


## CITY OF ANN ARBOR, MICHIGAN

# ARGO DAM TOE DRAIN IMPROVEMENTS

BID NO. ITB-4119 FILE NO. 11001

BID SET AUGUST 2010

Project Number: 2075116500

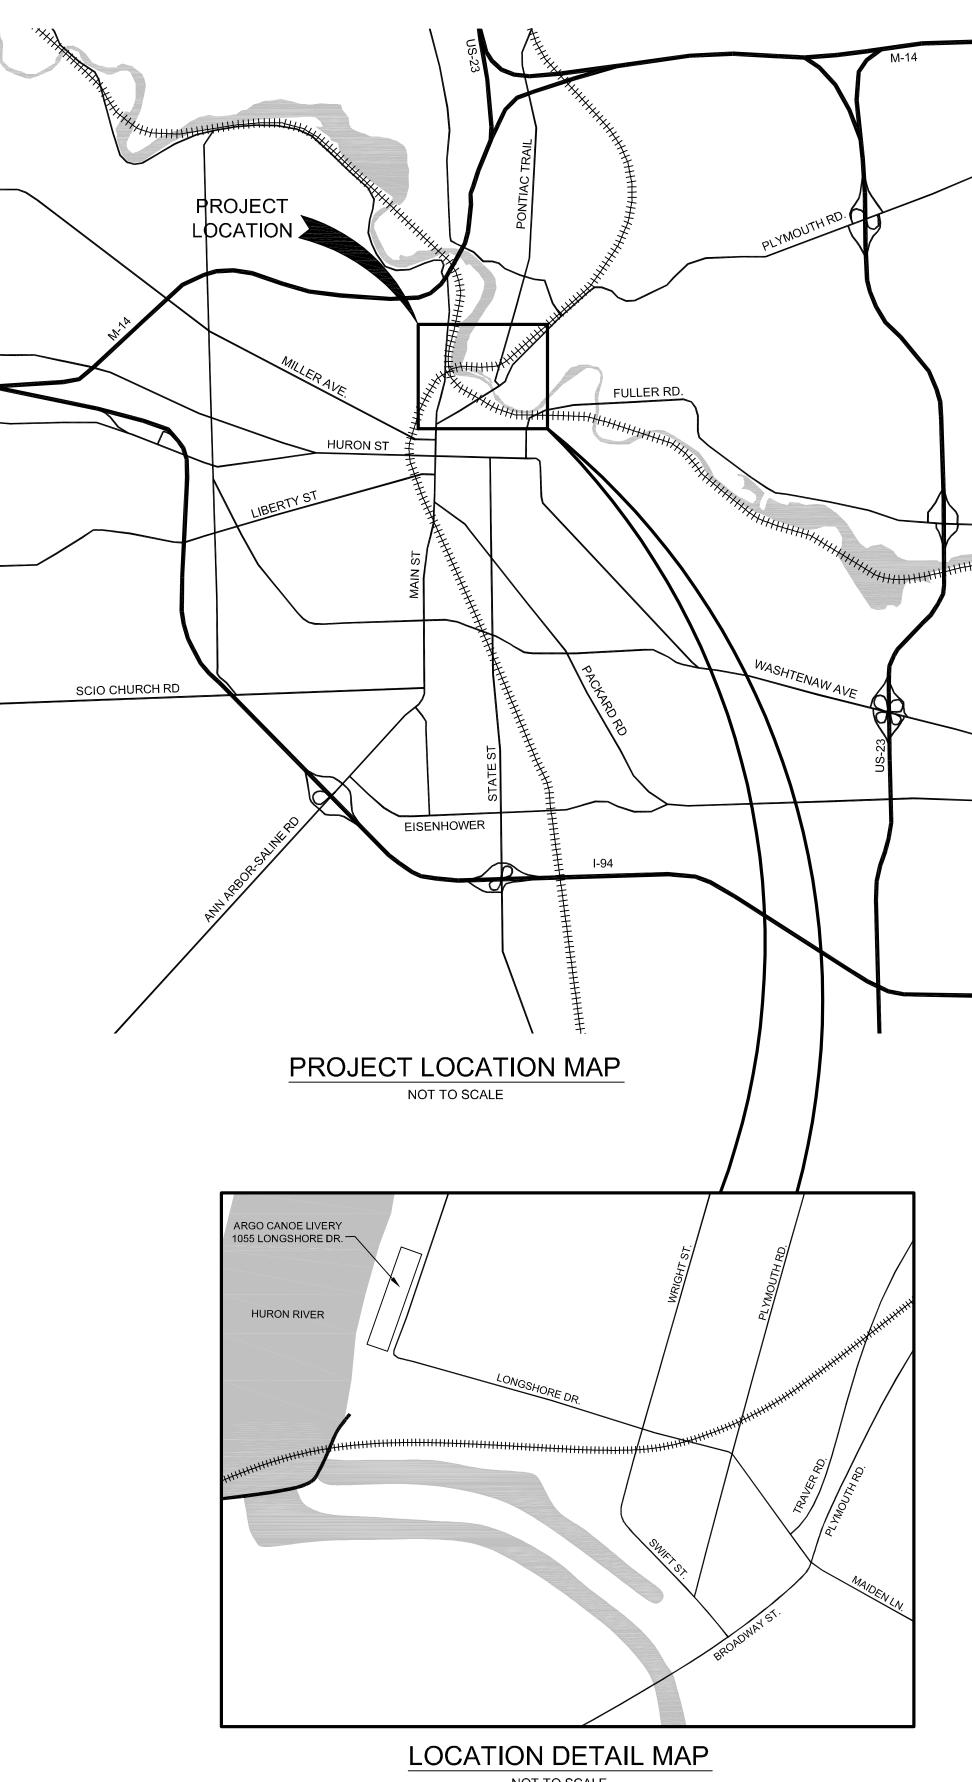


DRAWI	NG INDE	×
	. 10 11 10 1	.,

DWG	SHEET	TITLE	
GENER	AL SHEETS		
01	01	COVER SHEET	
02	02	PLAN VIEW	

ARGO POWER PLANT- HEAD RACE LAYOUT AND SECTIONS

**CROSS-SECTIONS** 

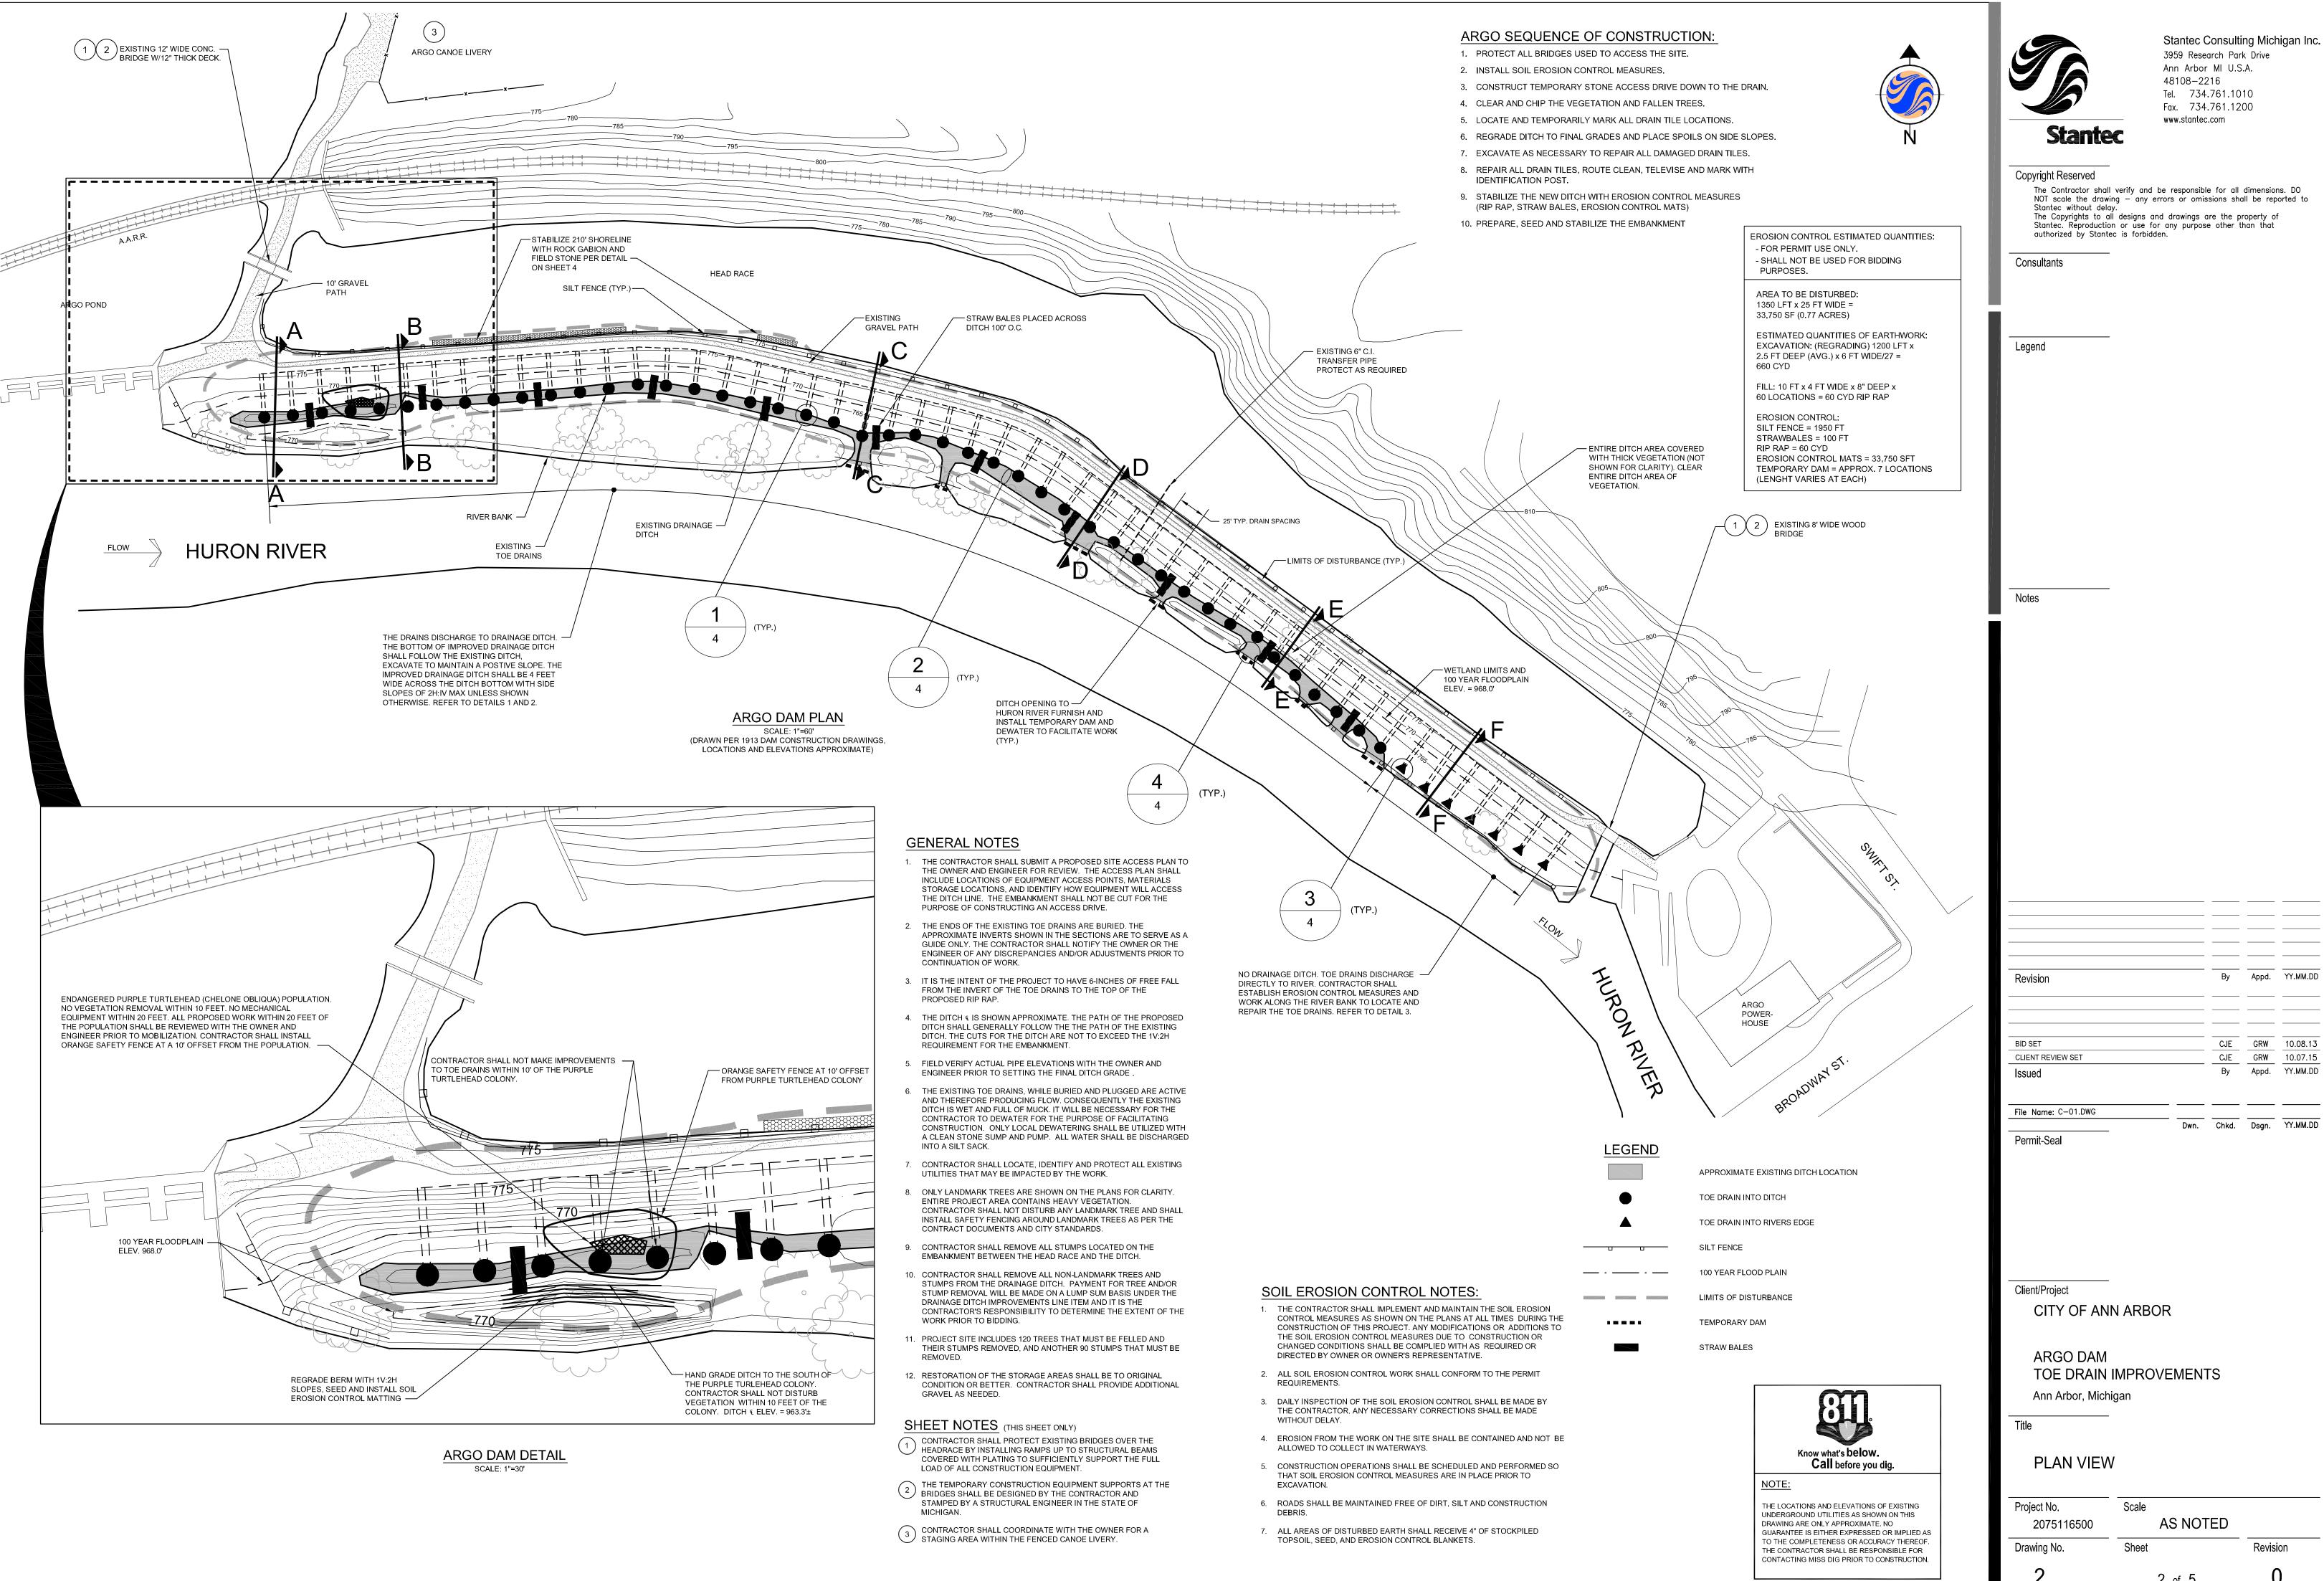



3959 Research Park Drive Ann Arbor MI U.S.A. 48108-2216 Tel. 734.761.1010


The Contractor shall verify and be responsible for all dimensions. DO NOT scale the drawing — any errors or omissions shall be reported to The Copyrights to all designs and drawings are the property of Stantec. Reproduction or use for any purpose other than that


CJE GRW 10.08.13 GRW 10.07.15 Chkd. Dsgn. YY.MM.DD


Project No. 2075116500	Scale AS NOTED	
Drawing No.	Sheet	Revision
2	2 of 5	0

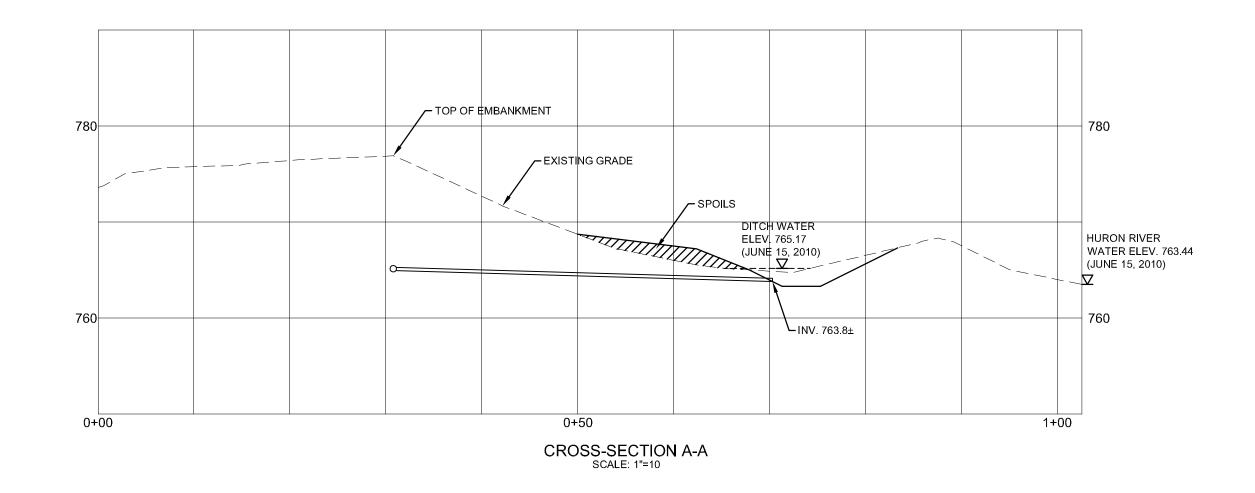


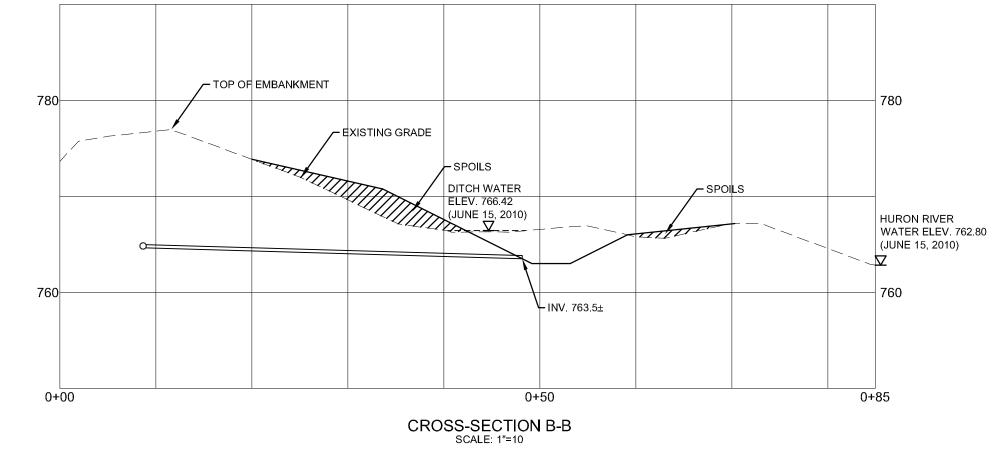

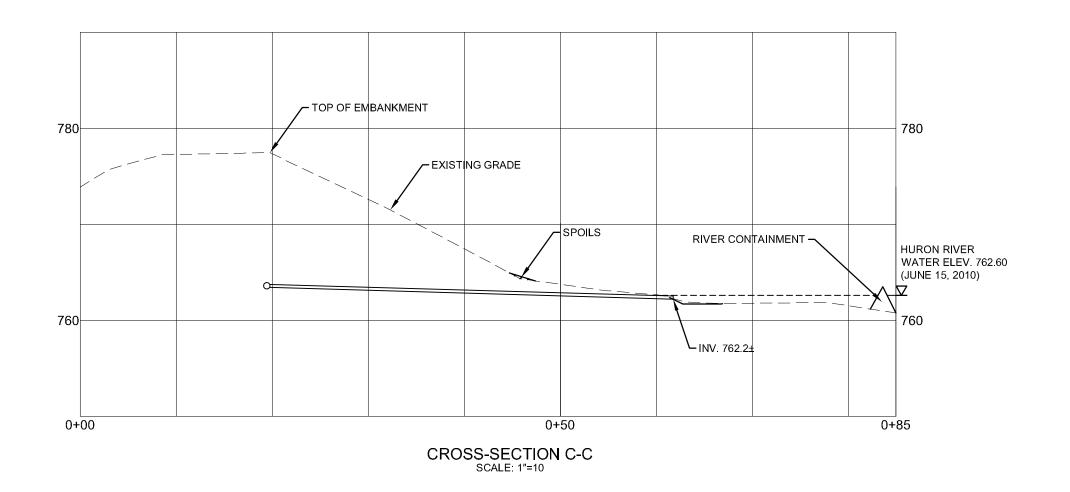

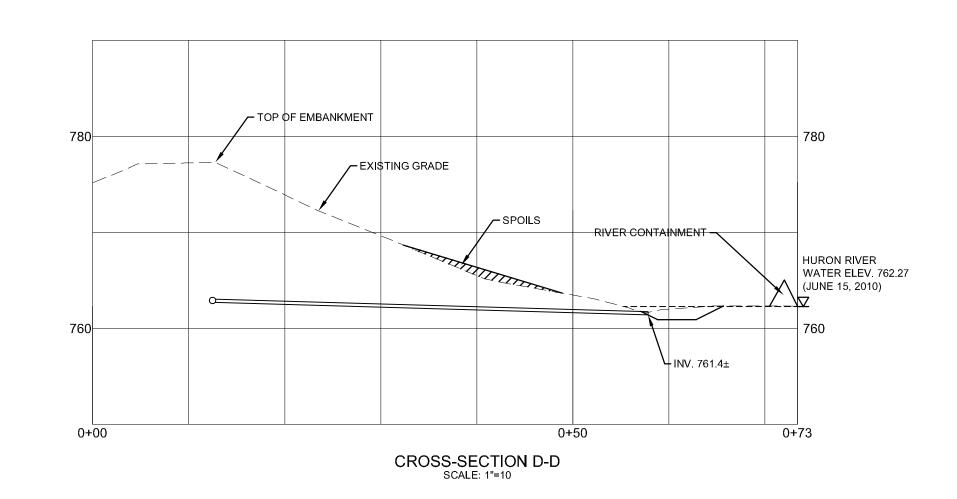

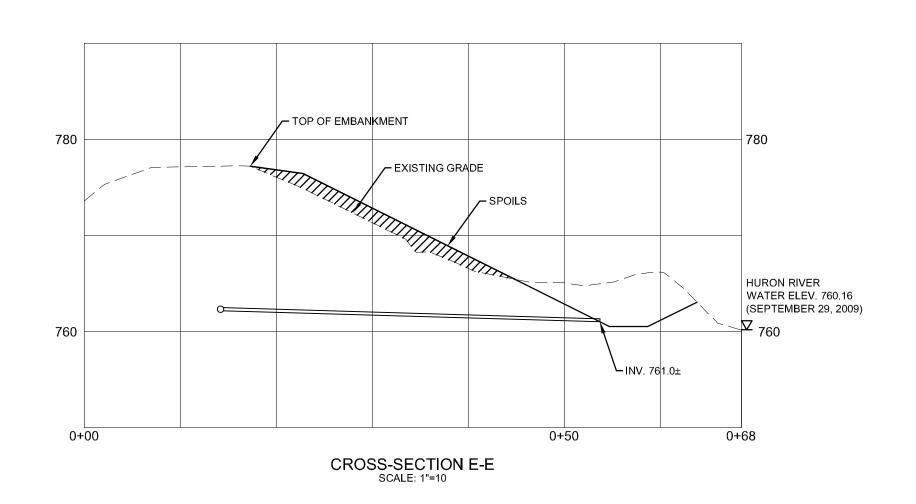

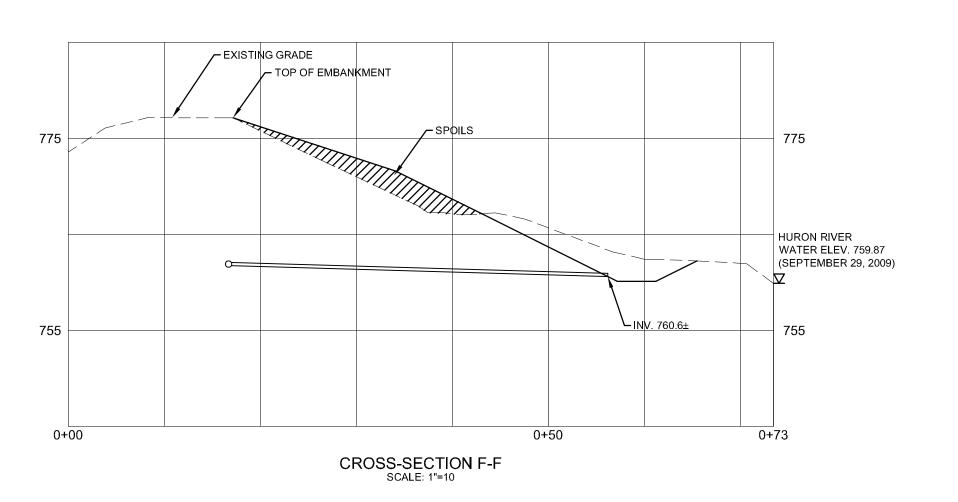



NOTE:

THE LOCATIONS AND ELEVATIONS OF EXISTING UNDERGROUND UTILITIES AS SHOWN ON THIS DRAWING ARE ONLY APPROXIMATE. NO GUARANTEE IS EITHER EXPRESSED OR IMPLIED AS TO THE COMPLETENESS OR ACCURACY THEREOF. THE CONTRACTOR SHALL BE RESPONSIBLE FOR CONTACTING MISS DIG PRIOR TO CONSTRUCTION.



#### Stantec Consulting Michigan Inc. 3959 Research Park Drive Ann Arbor MI U.S.A. 48108—2216 Tel. 734.761.1010 Fax. 734.761.1200

www.stantec.com

**Stantec** 

Copyright Reserved

The Contractor shall verify and be responsible for all dimensions. DO NOT scale the drawing — any errors or omissions shall be reported to Stantec without delay.

The Copyrights to all designs and drawings are the property of Stantec. Reproduction or use for any purpose other than that authorized by Stantec is forbidden.

Consultants

Legend

Notes

Client/Project

CITY OF ANN ARBOR

ARGO DAM TOE DRAIN IMPROVEMENTS

Ann Arbor, Michigan


CROSS-SECTIONS


Project No. Scale
2075116500 AS NOTED


Drawing No. Sheet Revision


3 of 5

0

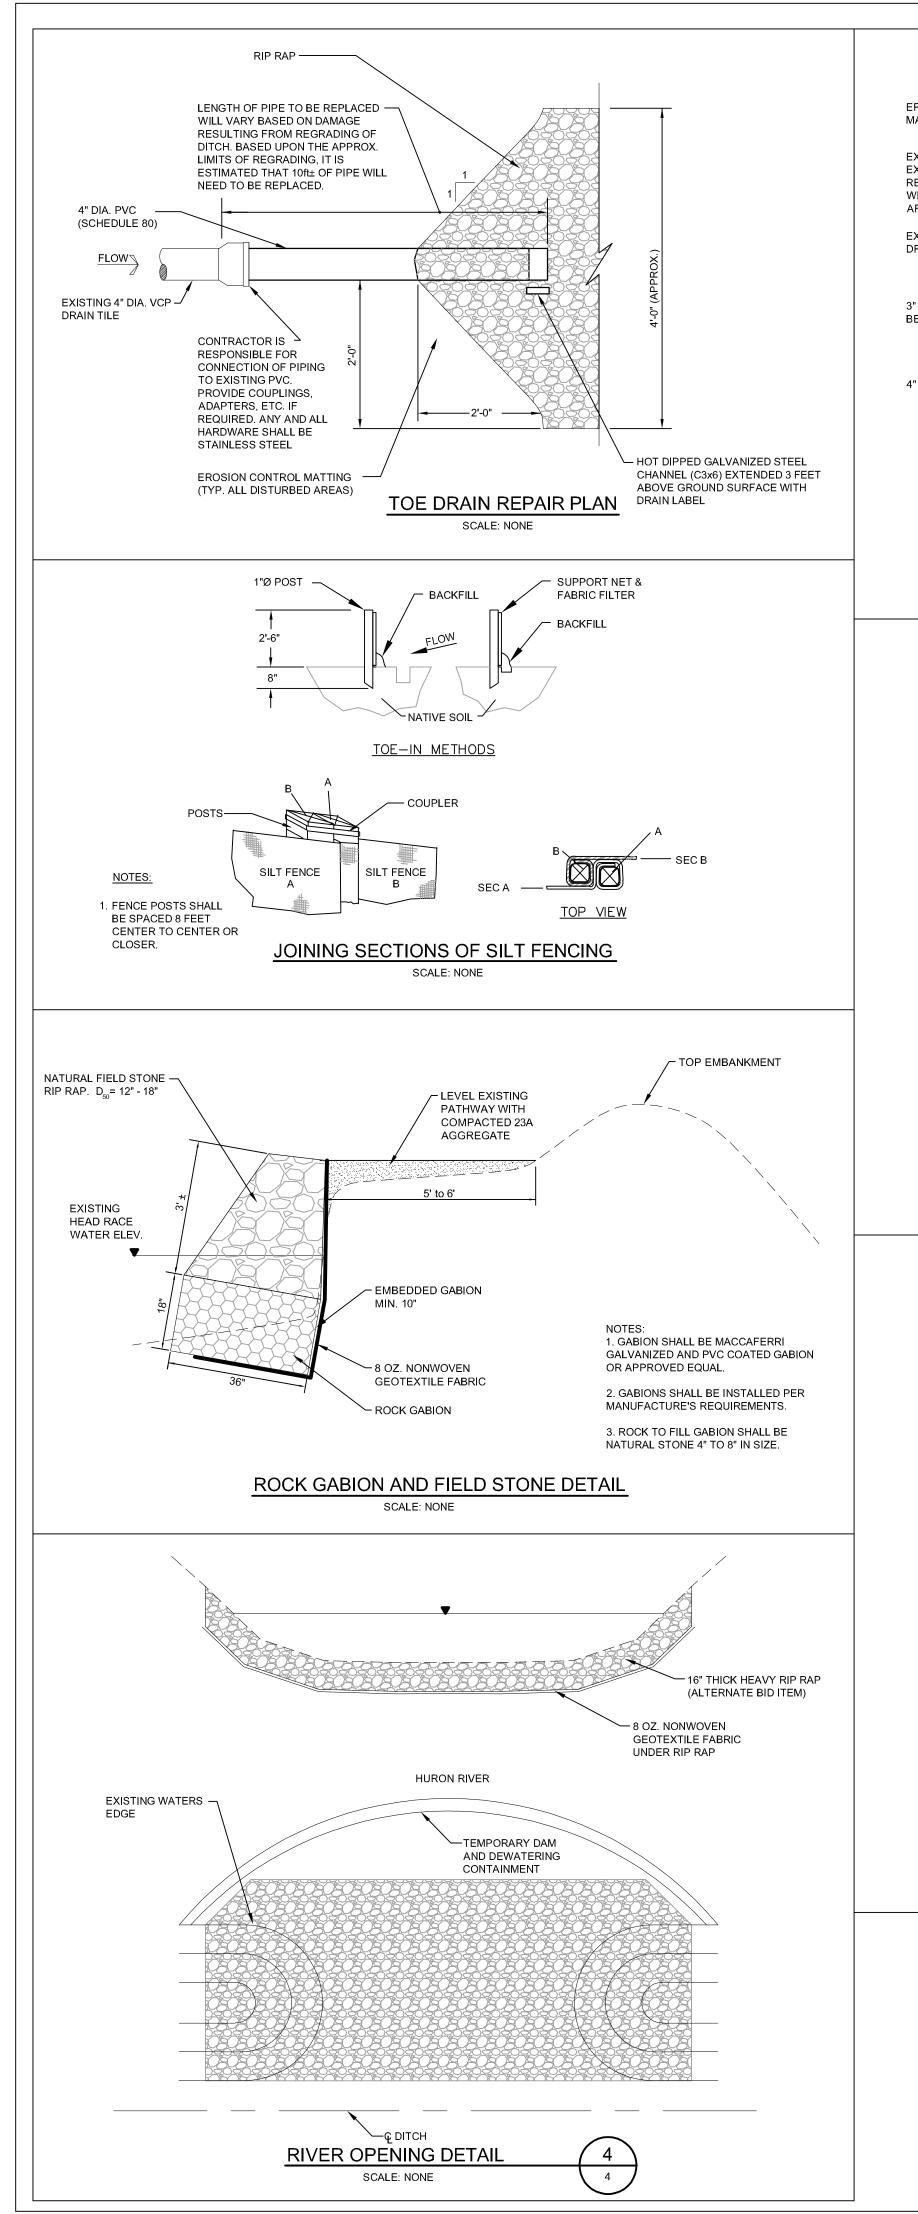

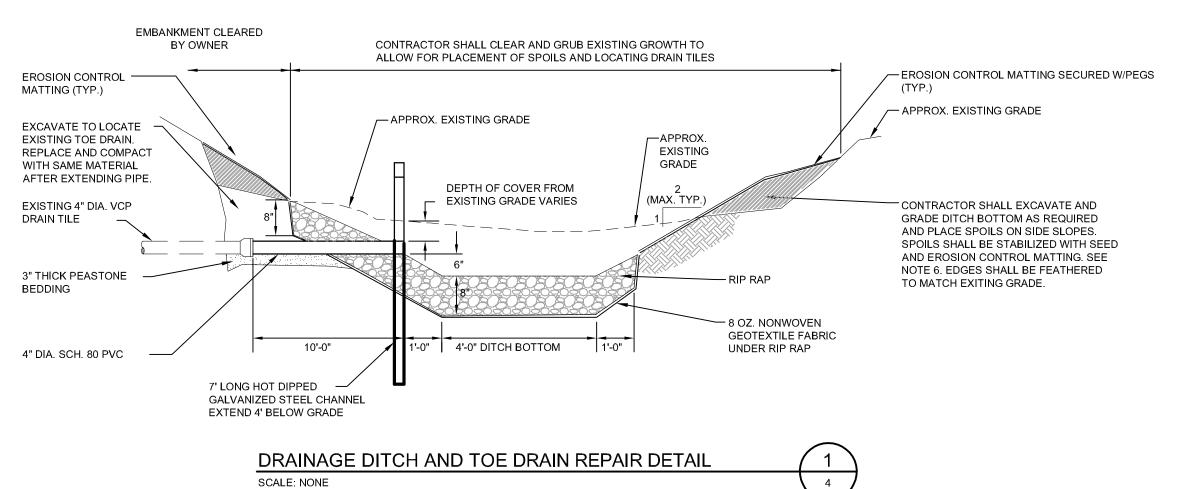


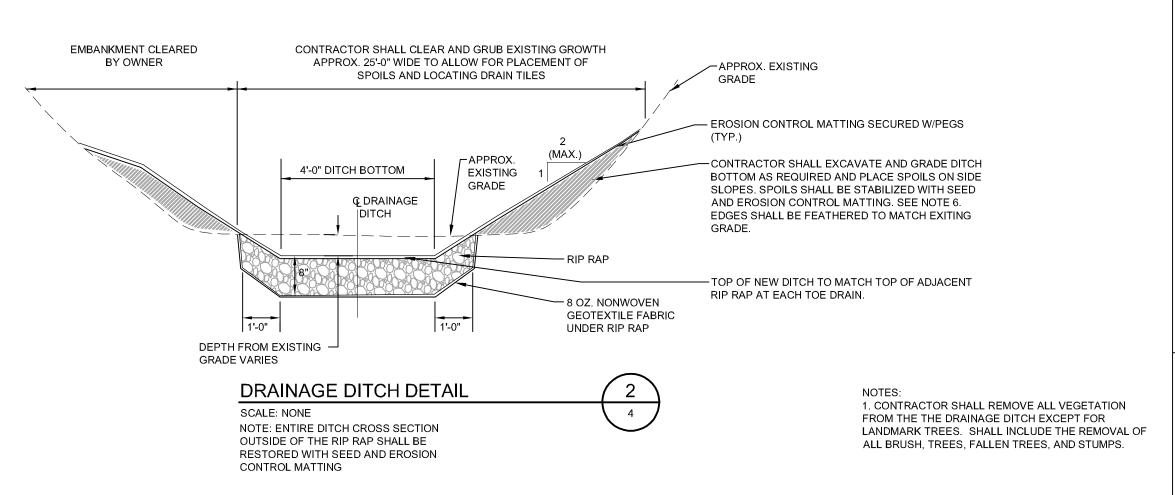

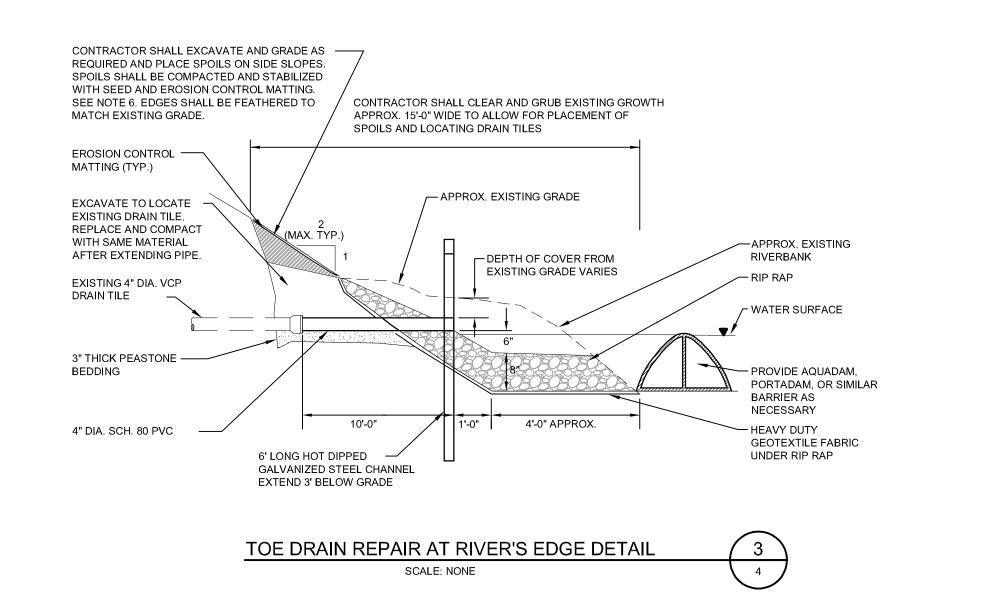


#### **GENERAL NOTES**

- 1. ALL EXISTING 4 INCH PVC DRAIN TILES SHALL BE LOCATED IN THE TOE-OF-SLOPE DRAINAGE DITCH BY CAREFULLY EXCAVATING ALONG THE DRAINAGE DITCH TO WHERE THE LOCATION OF EACH DRAIN TILE IS ANTICIPATED (APPROX. 25 FT ± 5 FT SPACING). INVERT ELEVATIONS OF EXISTING DRAIN TILES VARY.
- 2. EXPOSE END OF TOE DRAIN AND REMOVE ANY BROKEN OR DETERIORATED PIPE. REMOVE ANY BROKEN PIPE RESULTING FROM THE GRADING OPERATIONS. THIS MAY REQUIRE SOME EXCAVATION INTO THE EMBANKMENT TOE-OF-SLOPE. THE PIPE SHALL BE REMOVED TO THE NEAREST UNDISTURBED JOINT.
- 3. REPLACE BROKEN OR DETERIORATED PIPE WITH 4-INCH SCHEDULE 80 PVC PIPE. REPLACE TO FULL JOINT, I.E. TO PVC BELL JOINT. SEAL JOINT AT CONNECTION TO THE EXISTING PIPE WITH BUTYL JOINT SEALANT SIMILAR TO EZ-STIK AS MANUFACTURED BY PRESS-SEAL GASKET CORPORATION.
- 4. EXISTING DRAIN TILES SHALL BE CLEARED OF ACCUMULATED SEDIMENT. DRAIN TILES SHALL BE ROUTED CLEAN APPROXIMATELY 30 L.F. IN AND VIDEO INSPECTED. ROUTING OPERATIONS SHALL NOT COMPROMISE THE INTEGRITY OF VCP DRAIN TILES.
- 5. PLACE PERMANENT MARKERS AT THE END OF EACH TOE DRAIN. PERMANENT MARKERS TO BE 7'-0" LONG HOT DIPPED GALVANIZED STEEL CHANNEL (C3x6) DRIVEN 4'-0" INTO THE GROUND. LABEL CHANNEL WITH 3 INCH PAINTED NUMERAL. NUMBERS SHALL BEGIN AT WESTERN END OF PROJECT AND COUNT CONSECUTIVELY FROM WEST TO EAST.
- 6. ALL DISTURBED AREAS NOT RECEIVING AGGREGATE INCLUDING SIDESLOPES AND DITCH BOTTOMS SHALL RECEIVE STOCKPILED TOPSOIL AND SEED, INCLUDING EROSION CONTROL MATS.
- 7. THE BOTTOM OF THE IMPROVED DRAINAGE DITCH SHALL FOLLOW THE PATH OF THE EXISTING DITCH, EXCAVATED TO MAINTAIN A MINIMUM SLOPE OF 1/8 INCH PER FOOT. THE IMPROVED DRAINAGE DITCH SHALL BE 4 FEET WIDE ACROSS THE DITCH BOTTOM WITH SIDE SLOPES OF 2H:IV MAX UNLESS SHOWN OTHERWISE.

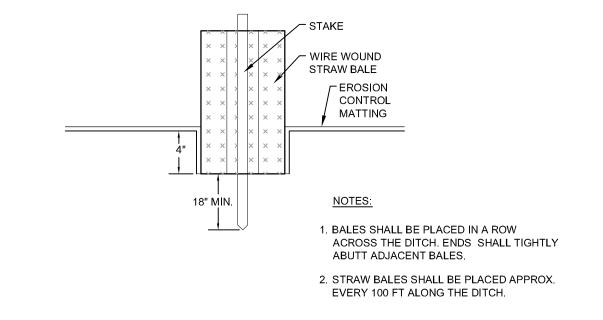


### STRAW BALE DETAIL SCALE: NONE

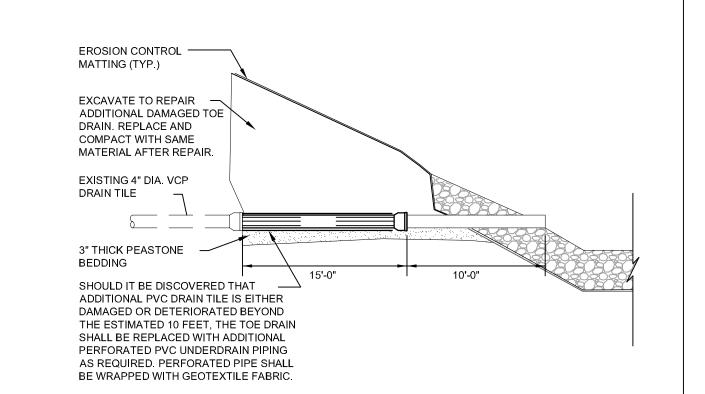

#### ADDITIONAL REPAIR DETAIL

SCALE: NONE

NOTE: WORK SHALL NOT PROCEED WITHOUT ON-SITE OWNER AND/OR ENGINEER INSPECTION.

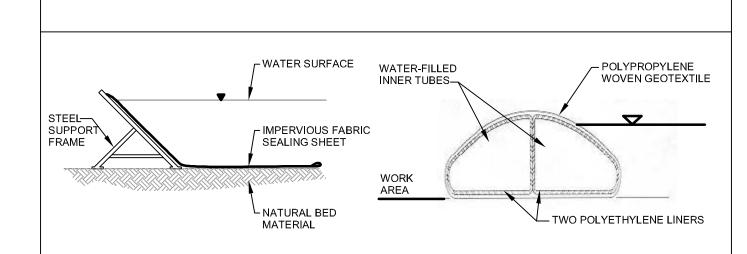


EXAMPLE PORTADAM INSTALLATION

EXAMPLE AQUADAM INSTALLATION

#### DEWATERING CONTAINMENT AT RIVER'S EDGE

THE ACTUAL METHOD FOR CONTAINMENT IS UP TO THE CONTRACTOR. TWO RECOMMENDED ALTERNATIVES INCLUDE THE AQUADAM (WATER STRUCTURES UNLIMITED; 1-800-682-9283) AND PORTADAM (PORTADAM, INC.; 1-800-346-4793). EXAMPLE DETAILS OF THESE CONTAINMENT METHODS ARE SHOWN ON THIS SHEET. THE CONTRACTOR MUST SUBMIT SHOP DRAWINGS AND INSTALLATION METHODS FOR REVIEW BEFORE INSTALLATION.

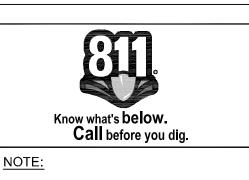

THE LOCATIONS AND ELEVATIONS OF EXISTING UNDERGROUND UTILITIES AS SHOWN ON THIS DRAWING ARE ONLY APPROXIMATE. NO GUARANTEE IS EITHER EXPRESSED OR IMPLIED AS TO THE COMPLETENESS OR ACCURACY THEREOF. THE CONTRACTOR SHALL BE RESPONSIBLE FOR CONTACTING MISS DIG PRIOR TO CONSTRUCTION.



Stantec Consulting Michigan Inc. 3959 Research Park Drive Ann Arbor MI U.S.A. 48108-2216 Tel. 734.761.1010

Fax. 734.761.1200

www.stantec.com

Stantec

authorized by Stantec is forbidden.

Copyright Reserved

The Contractor shall verify and be responsible for all dimensions. DO NOT scale the drawing — any errors or omissions shall be reported to Stantec without delay.

The Copyrights to all designs and drawings are the property of Stantec. Reproduction or use for any purpose other than that

Consultants

Legend

\_\_\_

Client/Project

CITY OF ANN ARBOR

ARGO DAM
TOE DRAIN IMPROVEMENTS

Ann Arbor, Michigan

DETAILS

Project No. Scale
2075116500 NO SCALE

Drawing No. Sheet Revision

4 of 5

0

